NOTE:

COMMERCIAL TILE GRID (SUPPLIED BY OTHERS) 2'X2' OR 2'X4'. GRID MUST BE SUPPORTED EVERY 4' IN EACH DIRECTION. TROY BOARD NOMINALLY 2'X8'6" MUST BE SINGLE SAW CUT TO FIT GRID. **NOT TO SCALE** FLOOR PLAN-FIXED POINT 10 LANE BULLET TRAP:
THIS DISTANCE WILL
VARY DEPENDING ON
TYPE OF BULLET TRAP TARGET LINE DELIV 1. TRUC
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9. TROY SYSTEM™ MATERIAL IN THE FIELD MANAGEMENT INSTRUCTIONS X UNLOADING

Do not unload Troy Board material by hand from truck.
When unloading or moving pallets of materials with forklift, material bundled or stacked on adjacent pallets.

Use extreme caution to not hit, scrape or dent the sides or Store all materials in a safe, secure and protected staging or storage area covered in a prot Do not unbundle Troy Boards and move or re-palletize boards by hand for storage. Do not unbundled Troy Wool until it is staged near its installation location. Material is shipp (DEPENDING TROY TROY SYSTEM
- ABSORPTION C COMMERCIAL SYSTEM TYP ON TARGET $\stackrel{\bigcirc}{\sim}$ GRADE EXISTING ON AC ACOUSTICAL 2'X2' WALL TILES SYSTEM ON 25 YD FIRING LINE -TROY SYSTEM
ABSORPTION C
COMMERCIAL C SHOOTER AND READY AREA ON ACCEILING 40'-8" INSIDE ACOUSTICAL 2'X2' TILES

NOTICE OF Proprietary & Confidential INFORMATION
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without the prior, written permission of Troy Acoustics Corporation. Contact:
800.987.3306 for more information.

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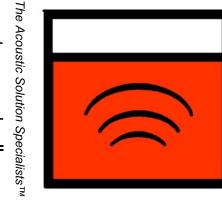
SHEET# **FLOORPLAN** DATE- 05-29-13

DRAWN BY- SLM SCALE- AS NOTED


REVISIONS:

RECOMMENDED GENERIC DRAWINGS FIXED POINT 10 LANE RANGE

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TROY
ACOUSTICS
CORPORATION



8'-0" J CHANNEL @ 6" A.F.F. RANGE VENTILATLION RADIAL DIFFUSER (SEE 3'-8" MECH. **DRAWINGS**) SEE TROY COVERAGE: SHEET A4 FOR DETAIL

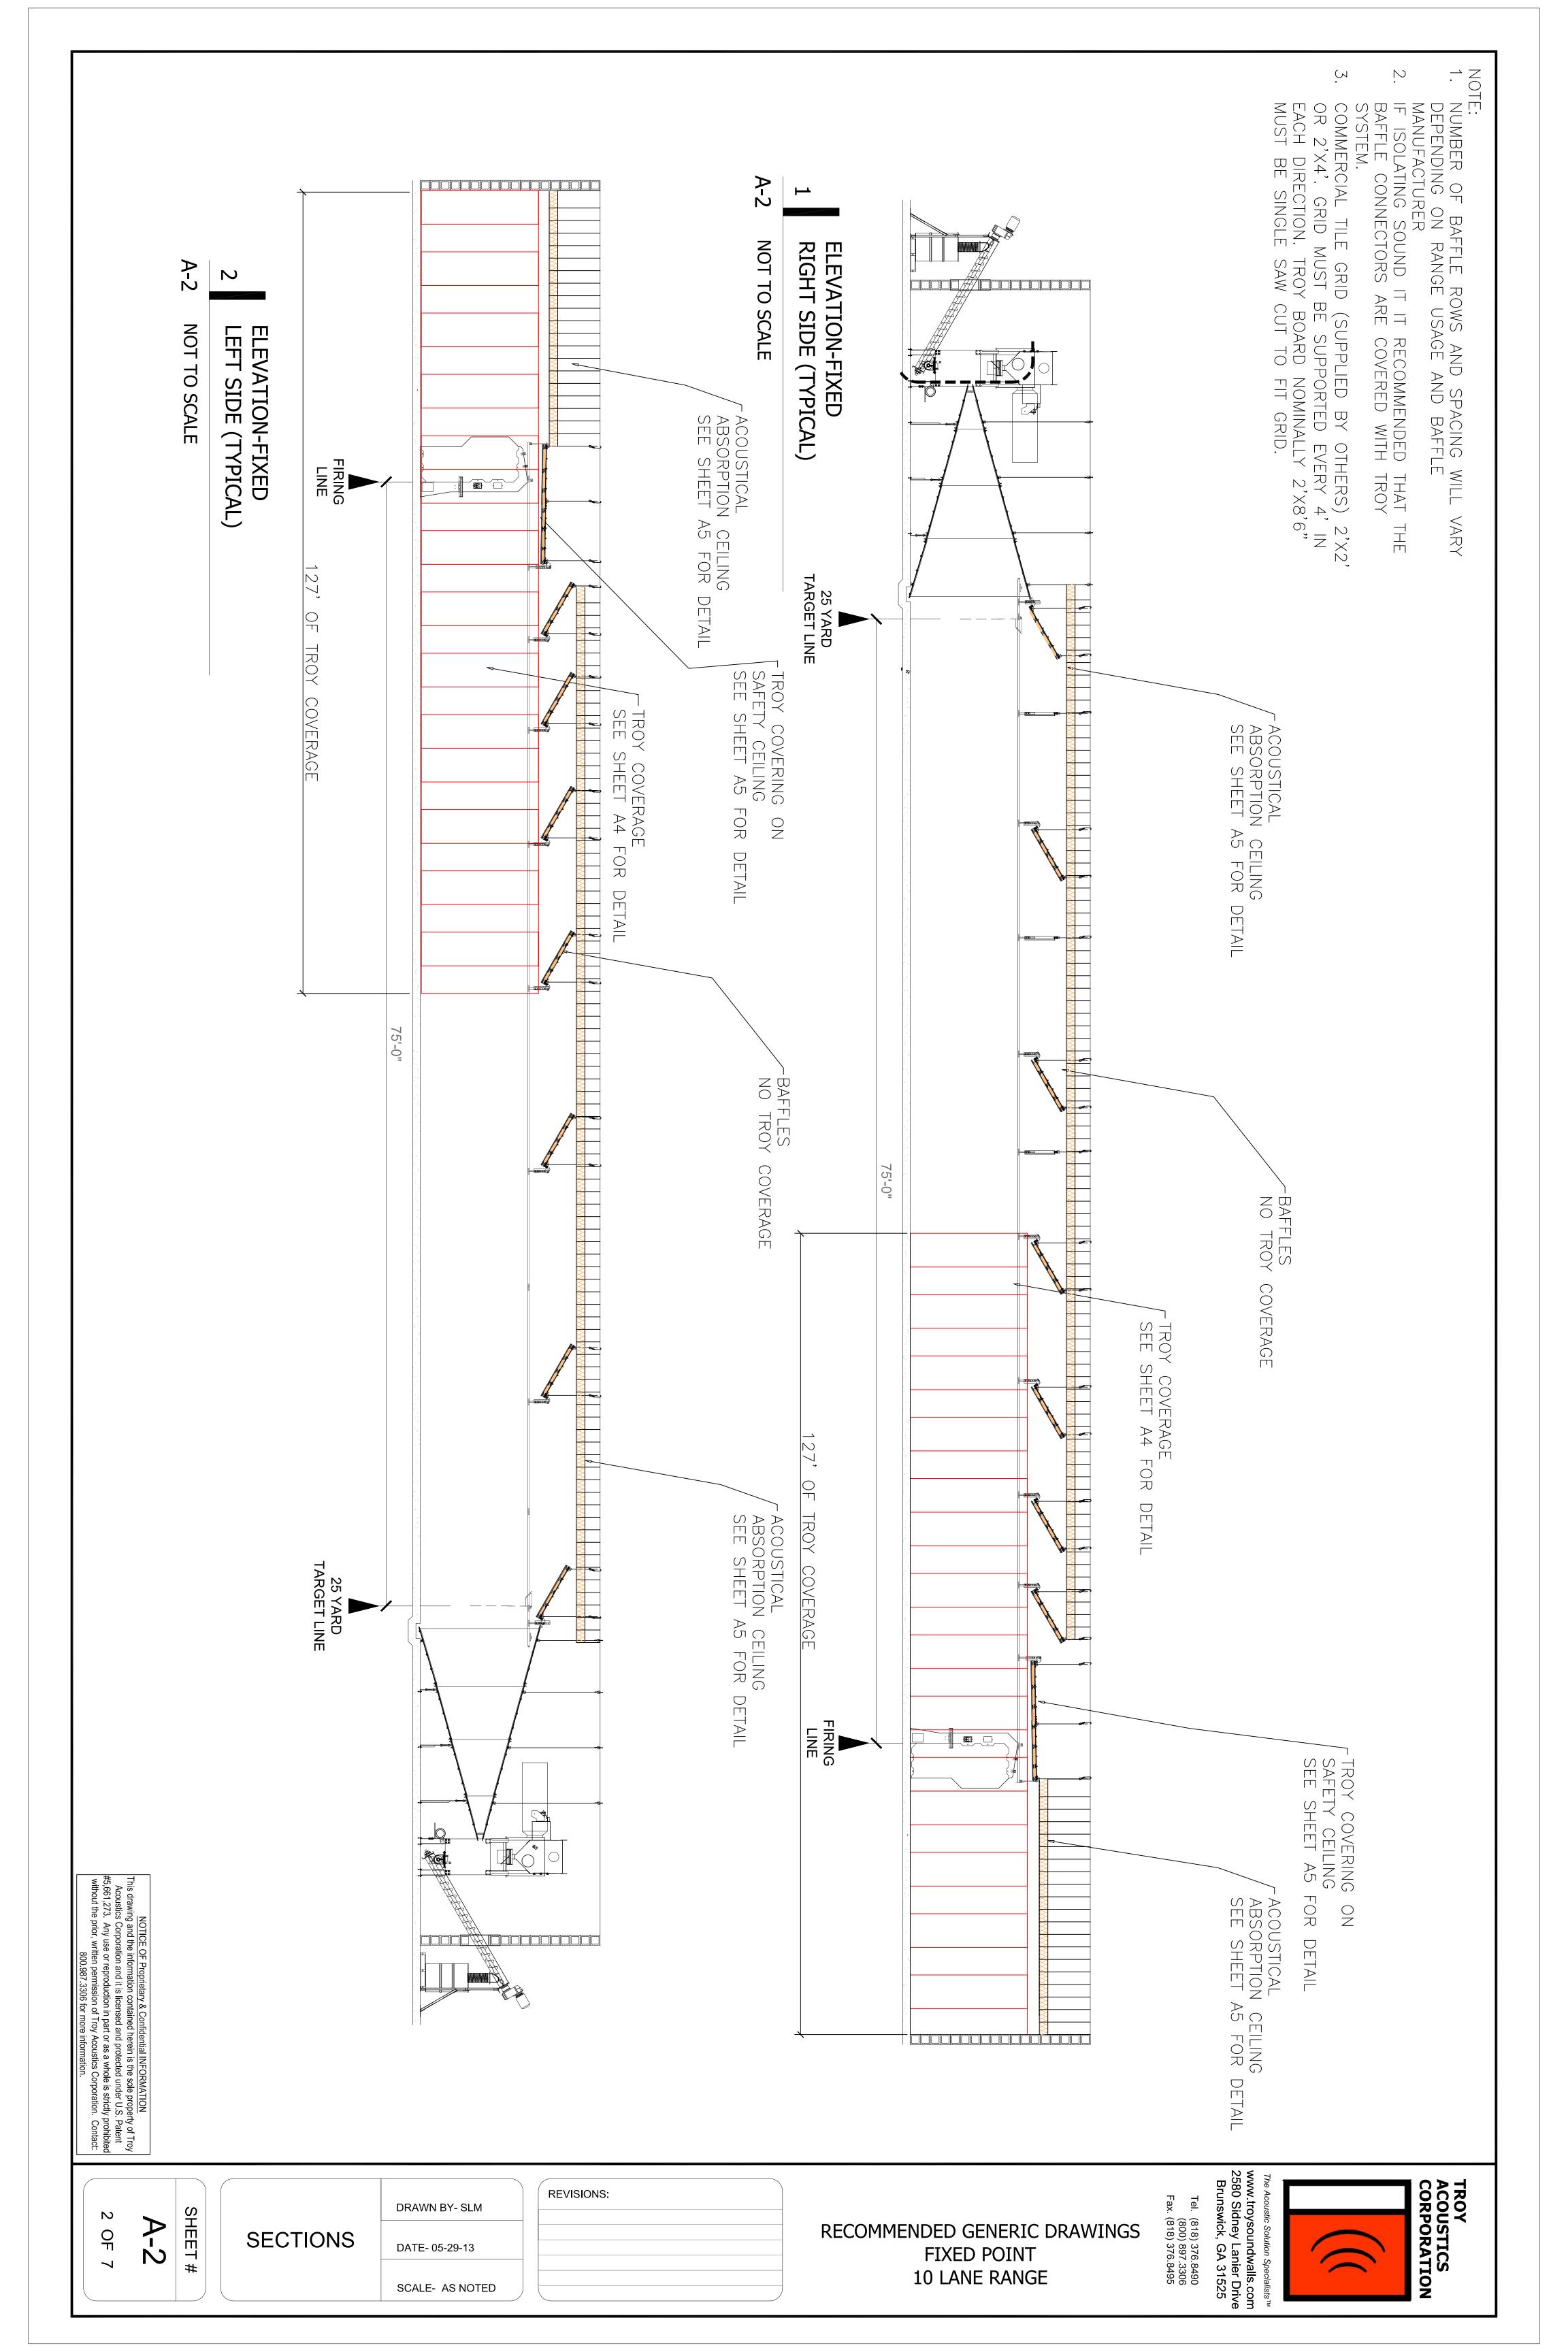SHEET# QF

REAR WALL SECTIONS

2

REAR WALL ELEVATION


SCALE:


1/8"=1'-0"

DRAWN BY- SLM DATE- 05-29-13 SCALE- AS NOTED **REVISIONS:**


RECOMMENDED GENERIC DRAWINGS FIXED POINT 10 LANE RANGE

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NOT TO SCALE SIDEWALL DETAIL -**TOP VIEW**

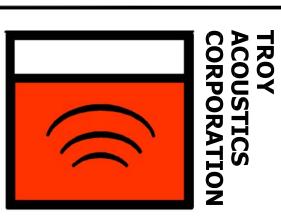

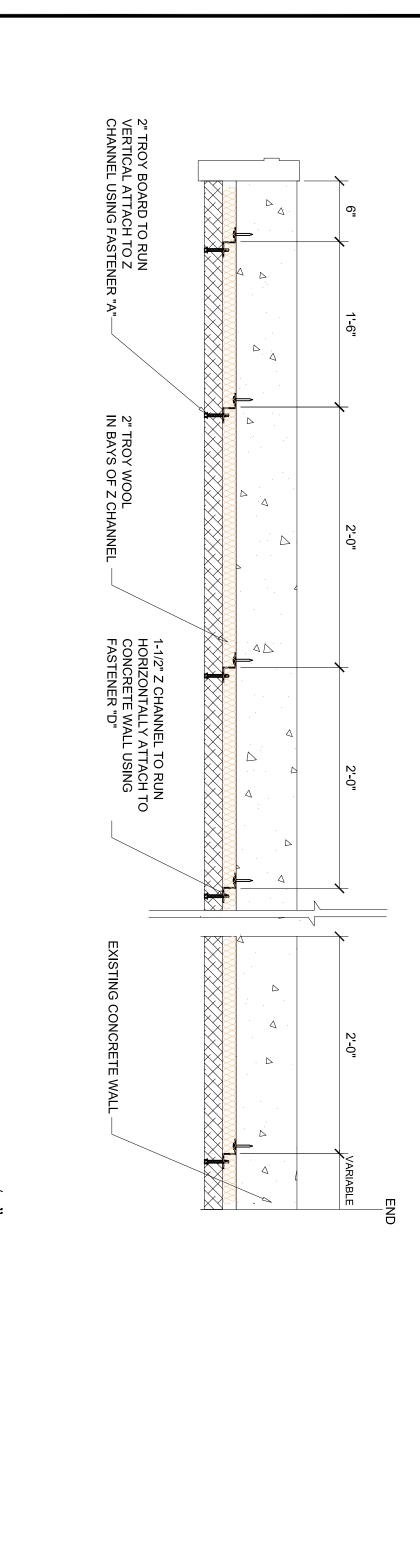2" TROY BOARD TO RUN VERTICALLY ATTACH TO Z CHANNEL USING FASTENER "A' 2" TROY WOOL IN BAYS OF Z CHANNEL 2-0 2

 ω **NOT TO SCALE** REAR WALL DETAIL **TOP VIEW**

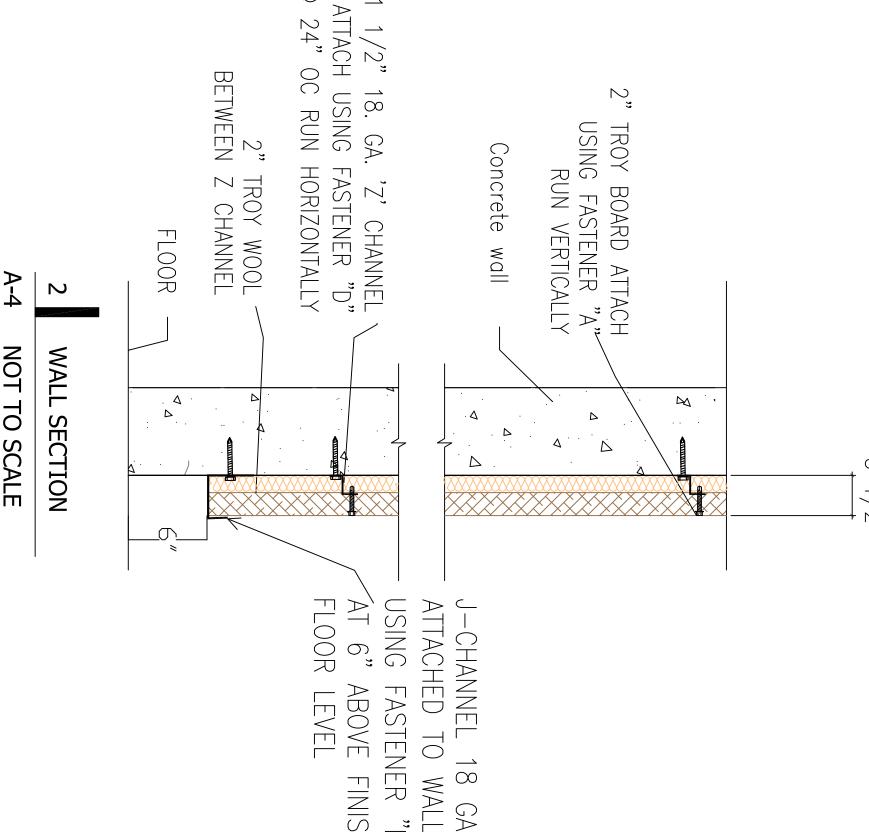SYSTEM. (
SIDEWALLS
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" GYPSUM SIDEWALLS

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NOTE:

DRAWINGS

ISOLATION ARE BASED

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REQUIREMENTS: N 1.3 SECONDS

Wall Install Procedure (Troy Board HORIZONTAL finish)

the same method * Note if "J-channel" is called out, it should be installed before furring channels in

Attachment of furring channel to wall is per detail provided. The furring are attached to all walls to be covered with Troy System. On the sidewalls and starting from left to right, lay out for the furring will run VERTICAL. Spacing for furring strips is 2' o.c. Start layout at 6" floor, or start of treatment, for first furring channel. Then follow spacing channels of 2' o.c. channel

2. Attachment of 2" Troy Wool to wall surface using a spray adhesive (3M-90 or equal). The spray adhesive is to hold the Troy Wool in place until the Troy Board material is attached. The 2' width of the Troy Wool should fit snug in the bays of the furring channel. Use a 10" serrated bread knife to cut the Troy Wool. Cover entire designated surface with Troy Wool.

3. Start layout of Troy Board perpendicular to furring channel. Start the first course with the end (2' width side) of Troy Board flush against wall and the top side of Troy Board MUST BE LEVEL. DO NOT RELY ON FLOOR TO BE LEVEL. All cuts will be on floor side, thus leaving factory side for second course to set upon. DO NOT INSTALL CUT SIDE UP. Using the supplied Troy Board fasteners, attach Troy Board to furring strips with fasteners every 11.8" per Troy Board is to be installed without edges damaged. Troy Board may be cut using a circular saw, hand saw, or reciprocating saw type. The Troy Board is manufactured with Portland cement; thereby dust will be created when using a

The Troy Board material is 8'-6" long and WILL NOT fall on lay out of the furring strips. Therefore, attach two (2) additional furring strips, no longer than 8" ea, to wall surface located at end of Troy Board. These furring channels will keep the Troy Board flat and even from end to end. Spacing of furring channels at end of Troy Boards are to be at least 12" apart from each other, with 4" under the Troy Board just installed, and the other 4" is for the attachment of the next Troy Board.

manner cut in around angled baffles. The piece should be of a triangle shape. This shape to be cut out of a Troy Board in one piece. The triangular shaped piece is to be attached to the furring strips with the smaller point located to the lowest baffle point and the larger portion of the triangular shape to finish flush and plum with the baffle or safety ceiling to its left. Continue installation of Troy Board material as per plans and details In same

ABOVE FINISH

FASTENER "D"

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GAUGE

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EMENTS: SINCE THESE SECONDS REVERBERATION DOES NOT CONSIDER UM, ISOLATION REQUIRES OF THESE DIMENTALLED DIRECTLY MUSHROOM HEAD INSTALL PROCEDURE Hammer the anchor through the J or Z channels inot the anchor hole until the head is firmly against the metal. Be sure the anchor is driven Blow the hole clean of dust and other material. a hole into the base material to a depth of at least 1/2" or one anchor diameter deeper than the to the required embedment depth. Using the proper diameter bit, drill

FASTENERS

TROY
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 \triangleright

#14 X 3 " SELF TAPPING HEX HEAD SCREW USED TO FASTEN BOARD TO Z-BAR

 \sharp 14 X 2 " SELF TAPPING HEX HEAD SCREW USED TO FASTEN BOARD TO Z-BAR

 \Box

1/4" X 2" LAG SCREW USED FOR CEILING APPLICATIONS

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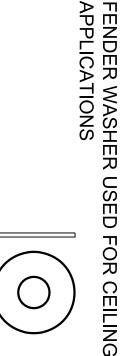
Tel. (818) 376.8490 (800) 897.3306 Fax. (818) 376.8495

 \circ

1/4" X 1 1/2" MUSHROOM HEAD SPIKE USED TO FASTEN Z-BAR, J CHANNEL & CLIPS TO CONCRETE STRUCTURE

 \Box





ABBREVIATIONS

(N) NTS OC SQ STAGG ₩TYP BLKG (E) AFF ₽B ANCHOR BOLT
ABOVE FINISHED FLOOR
BLOCKING
CONCRETE MASONRY UNIT
EXISTING
GAUGE NOT TO SCALE
ON CENTER
SQUARE
STAGGERED
TROY BOARD™
TO BE DETERMINED
TROY WOOL™
TYPICAL NEW NOT: **WITH**

GENERAL NOTES

ALL CONDUITS, JUNCTION BOXES, ELECTRICAL BOXES AND PANELS ARE TO BE SURFACED MOUNTED TO THE TROY SYSTEM $^{\rm TM}$. NO CUT OUTS FOR THESE TO BE PERFORMED. (U.O.N)

SCREWS USED TO FASTEN TROY BOARD $^\mathsf{TM}$ ARE TO LIE FLUSH WITH THE PANEL.

VOIDS PAINT INSTRUCTIONS: USE AN AIRLESS SPRAYER WITH ACRYLIC LATEX BASE PAINT (2 - 3 COATS MAX). DO NOT FILL IN

INSTALLATION OF PANELS SHOULD BEGIN WITH A 2'-0" X 8'-6" PANEL ON THE BOTTOM INSIDE CORNER OF WALL CONTINUING DOWN THE END OF RANGE.


THICK TROY BOARD™ USED FOR WALLS

1" THICK TROY BOARD $^{\text{TM}}$ USED FOR BAFFLES AND CEILING UNLESS OTHERWISE NOTED.

Z-CHANNELS ON BAFFLES RUN LONGITUDINALLY (UP AND DOWN RANGE). TROY BOARD™ WILL RUN ACROSS (LEFT T

MATERIALS

TROY WOOL™ TROY BOARD™

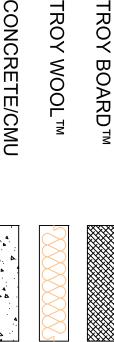

SHEET#

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DETAILS


DRAWN BY-SLM DATE- 05-29-13 SCALE- AS NOTED

REVISIONS:

FIXED POINT

RECOMMENDED GENERIC DRAWINGS 10 LANE RANGE

1" TROY BOARD FASTENED TO 2 X FURRING USING FASTENER 'C'&'E' AS PER INSTALLATION PROCEDURE. (SIDE SAFETY CEILING DETAIL SCALE: 1/4' = 4'-0" BEHIND FIRING LINE VIEW) 1'-0" TROY BOARDS RUN | FROM FRONT TO BACK ON SAFETY CEIL|NG **≢ILING STRUCTURE** 12'-0' (TYP.) SAFETY CEILING FIRING LINE 2X FURRING STRIPS ATTACHED TO ARMOR PLATE FROM SIDEWALL TO SIDEWALL @ 2' O.C. SUPPLIED BY OTHERS STEEL SAFE CEILING: 3/8 (BY OTHERS 'AR-500 1/2

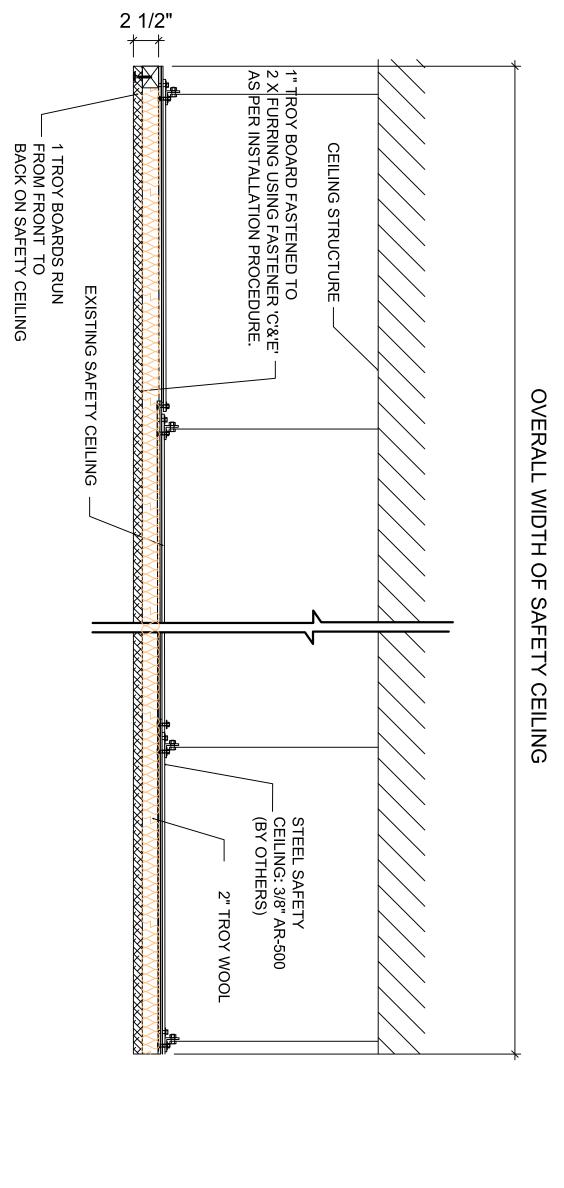

SUSPENSION WIRE

STANDARD COMMERCIAL ACOUSTICAL ABSORPTION CEILING **GRADE 2X2** II E

- Attachment of 2" Troy Wool to ceiling surface using a spray adhesive (3M-90 or equal). The spray adhesive is to hold the Troy Wool in place until the Troy Board material is attached. The 2' width of the Troy Wool should fit snug in the bays of the furring channel. Use a 10" serrated bread knife to cut the Troy Wool. Cover entire designated surface with Troy Wool.
 Start layout of Troy Board perpendicular to furring channel. Start the first course with the end (2' width side) of Troy Board flush against wall. Using the supplies Troy Board fasteners, attach Troy Board to furring strips with a minimum of 8 fasteners per Troy Board. Troy Board is a finish acoustic material. Make sure joints are tight. Troy Board is to be installed in a staggered seam method. i.e. As you start with the first course with a full sheet, the second course will start of with a half sheet. The pattern should look like masonry blocks once completed. Troy Board may be cut using a circular saw, hard saw or completed. Troy Board may be cut using a circular saw, hand saw, or reciprocating saw type. The Troy Board is manufactured with Portland cement, thereby dust will be created when using a circular saw.
- The Troy Board material is 8'-6" long and WILL NOT fall on lay out of the furring strips. Therefore, attach two (2) additional furring strips, no longer than 8" ea, to ceiling surface located at end of Troy Board. These furring channels will keep the Troy Board flat and even from end to end. Spacing of furring channels at end of Troy Boards are to be at least 12" apart from each other, with 4" under the Troy Board just installed, and the other 4" is for the attachment of the next Troy Board.

DROP DOWN 24"X24"X1" 6"TROY WOOL ABOVE TROY CEILING BOARD PANELS PANEL \bigcirc

NOT TO SCALE

2

(END VIEW)

NOT TO SCALE

SAFETY CEILING

DETAIL

NOTE:

COMMERCIAL TILE GRID (SUPPLIED BY OTHERS) 2'X2' OR 2'X4'. GRID MUST BE SUPPORTED EVERY 4' IN EACH DIRECTION. TROY BOARD NOMINALLY 2'X8'6" MUST BE SINGLE SAW CUT TO FIT GRID.

FASTENERS

Safety Ceiling Install Procedure (with furring supplied by Troy Acoustics)

 \triangleright #14 X 3 " SELF TAPPING HEX HEAD SCREW USED TO FASTEN BOARD TO Z-BAR

TROY
ACOUSTICS
CORPORATION

#14 X 2 " SELF TAPPING HEX HEAD SCREW USED TO FASTEN BOARD TO Z-BAR

 \Box

 \bigcirc

1/4" X 2" LAG SCREW USED FOR CEILING APPLICATIONS

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Tel. (818) 376.8490 (800) 897.3306 Fax. (818) 376.8495

 \Box

- 1/4" X 1 1/2" MUSHROOM HEAD SPIKE USED TO FASTEN Z-BAR, J CHANNEL & CLIPS TO CONCRETE STRUCTURE
- FENDER WASHER USED FOR APPLICATIONS CEILING

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ABBREVIATIONS

AFF ANCHOR BOLT
ABOVE FINISHED FLOOR
BLOCKING
CONCRETE MASONRY UNIT
EXISTING
GAUGE NEW

BLKG
CMU
(E)
GA
(N)
NTS
OC
SQ
STAGG
TB
TW
TYP
W NOT TO SCALE
ON CENTER
SQUARE
STAGGERED
TROY BOARD™
TO BE DETERMINED
TROY WOOL™
TYPICAL

GENERAL NOTES

WITH

ALL CONDUITS, JUNCTION BOXES, ELECTRICAL BOXES AND PANELS ARE TO BE SURFACED MOUNTED TO THE TROY SYSTEM $^{\rm TM}$. NO CUT OUTS FOR THESE TO BE PERFORMED. (U.O.N)

REVISIONS:

SCREWS USED TO FASTEN TROY BOARD $^{\mathsf{TM}}$ ARE TO LIE FLUSH WITH THE PANEL.

PAINT INSTRUCTIONS: USE AN AIRLESS SPRAYER WITH ACRYLIC LATEX BASE PAINT (2 - 3 COATS MAX). DO NOT FILL IN VOIDS.

INSTALLATION OF PANELS SHOULD BEGIN WITH A 2'-0" PANEL ON THE BOTTOM INSIDE CORNER OF WALL CONTINUING DOWN THE END OF RANGE. X 8'-6"

DRAWN BY- SLM

DATE- 05-29-13

SCALE- AS NOTED

THICK TROY BOARD™ USED FOR WALLS

1" THICK TROY BOARD TM USED FOR BAFFLES AND CEILING UNLESS OTHERWISE NOTED.

Z-CHANNELS ON BAFFLES RUN LONGITUDINALLY (UP AND DOWN RANGE). TROY BOARD™ WILL RUN ACROSS (LEFT T

MATERIALS

CONCRETE/CMU

TROY WOOL™

TROY BOARD™



CEILING DETAILS


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RECOMMENDED GENERIC DRAWINGS FIXED POINT 10 LANE RANGE










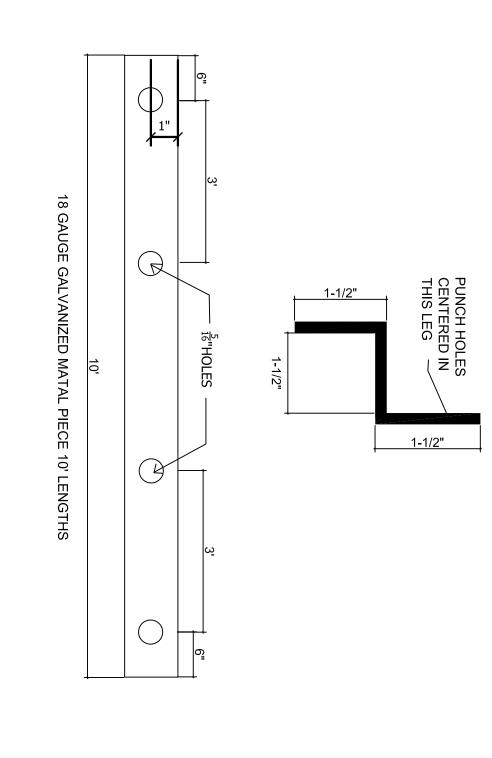

24 GAUGE GALVANIZED METAL PIECE 10' LENGTHS

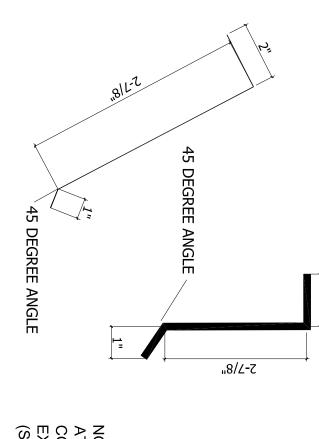

24 GUAGE GALVANIZED SHEET METAL EXTRUSIONS PIECE 10' LENGTHS NOTE:
ATTACH DRIP EDGE TO BAFFLE USING
CONSTRUCTION ADHESIVE - USED IN
EXTERIOR RANGES ONLY
(SUPPLIED BY OTHERS)

EDGE METAL NOT TO SCALE

2

J CHANNEL DETAIL

18 GUAGE GALVANZIED METAL PIECE 10' LENGTHS

R

 $\frac{5}{16}$ "HOLES


NOT TO SCALE

SHEET# 0 A-6 유

DRAWN BY- SLM **DETAILS** DATE- 05-29-13 SCALE- AS NOTED **REVISIONS:**

RECOMMENDED GENERIC DRAWINGS FIXED POINT 10 LANE RANGE

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SHEET#

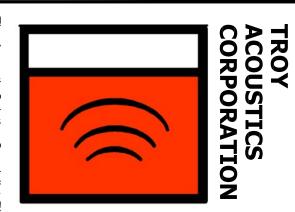DETAILS

QF


DRAWN BY- SLM

DATE- 05-29-13

SCALE- AS NOTED

REVISIONS:

TOLERANCES NOT TO SCALE SUBSTRATE ROUGH FINISH
TOLERANCE FOR TROY BOARD
2" TROY BOARD SHOWN SITE LINE SITE LINE 1" TROY BOARD SHOWN MAX = $\frac{3}{8}$ ":8 FT (+/- $\frac{3}{16}$ " = $\frac{1}{2}$) FOR 2" TROY BOARD $=\frac{1}{4}$ ":8 FT (+/- $\frac{1}{8}$ " = $\frac{\triangle}{2}$) FOR 1" TROY BOARD $\frac{1}{100}$ MAX = $\frac{1}{8}$ " (+/- $\frac{3}{16}$ ") TROY BOARD TYPICAL SUBSTRATE ROUGH FINISH TOLERANCES 9'-0" 4'-0" FURRING 2 X 4 OR
18 GAUGE METAL "Z" (TYP.) = +/- 16" PER 4'-0" FURRING 2 X 4 OR L.W. STEEL – (TYP.) BAFFLE VIEW - ELEVATION PERSCPECTIVE FROM FIRING POSITION TOWARD TARGET 2" TROY BOARD EXAMPLE BAFFLE SECTION SHOWN 1" X 2' X 8' TROY BOARD (TYP.) AR STEEL PLATE AR STEEL PLATE (TYP.) SUBSTRATE SURFACE

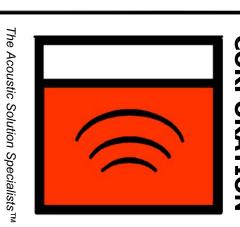

RECOMMENDED GENERIC DRAWINGS FIXED POINT

10 LANE RANGE

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